


FOR ATTENUATION SYSTEM DIMENSIONS REFER TO PROJECT SPECIFIC SITE DRAINAGE PLAN

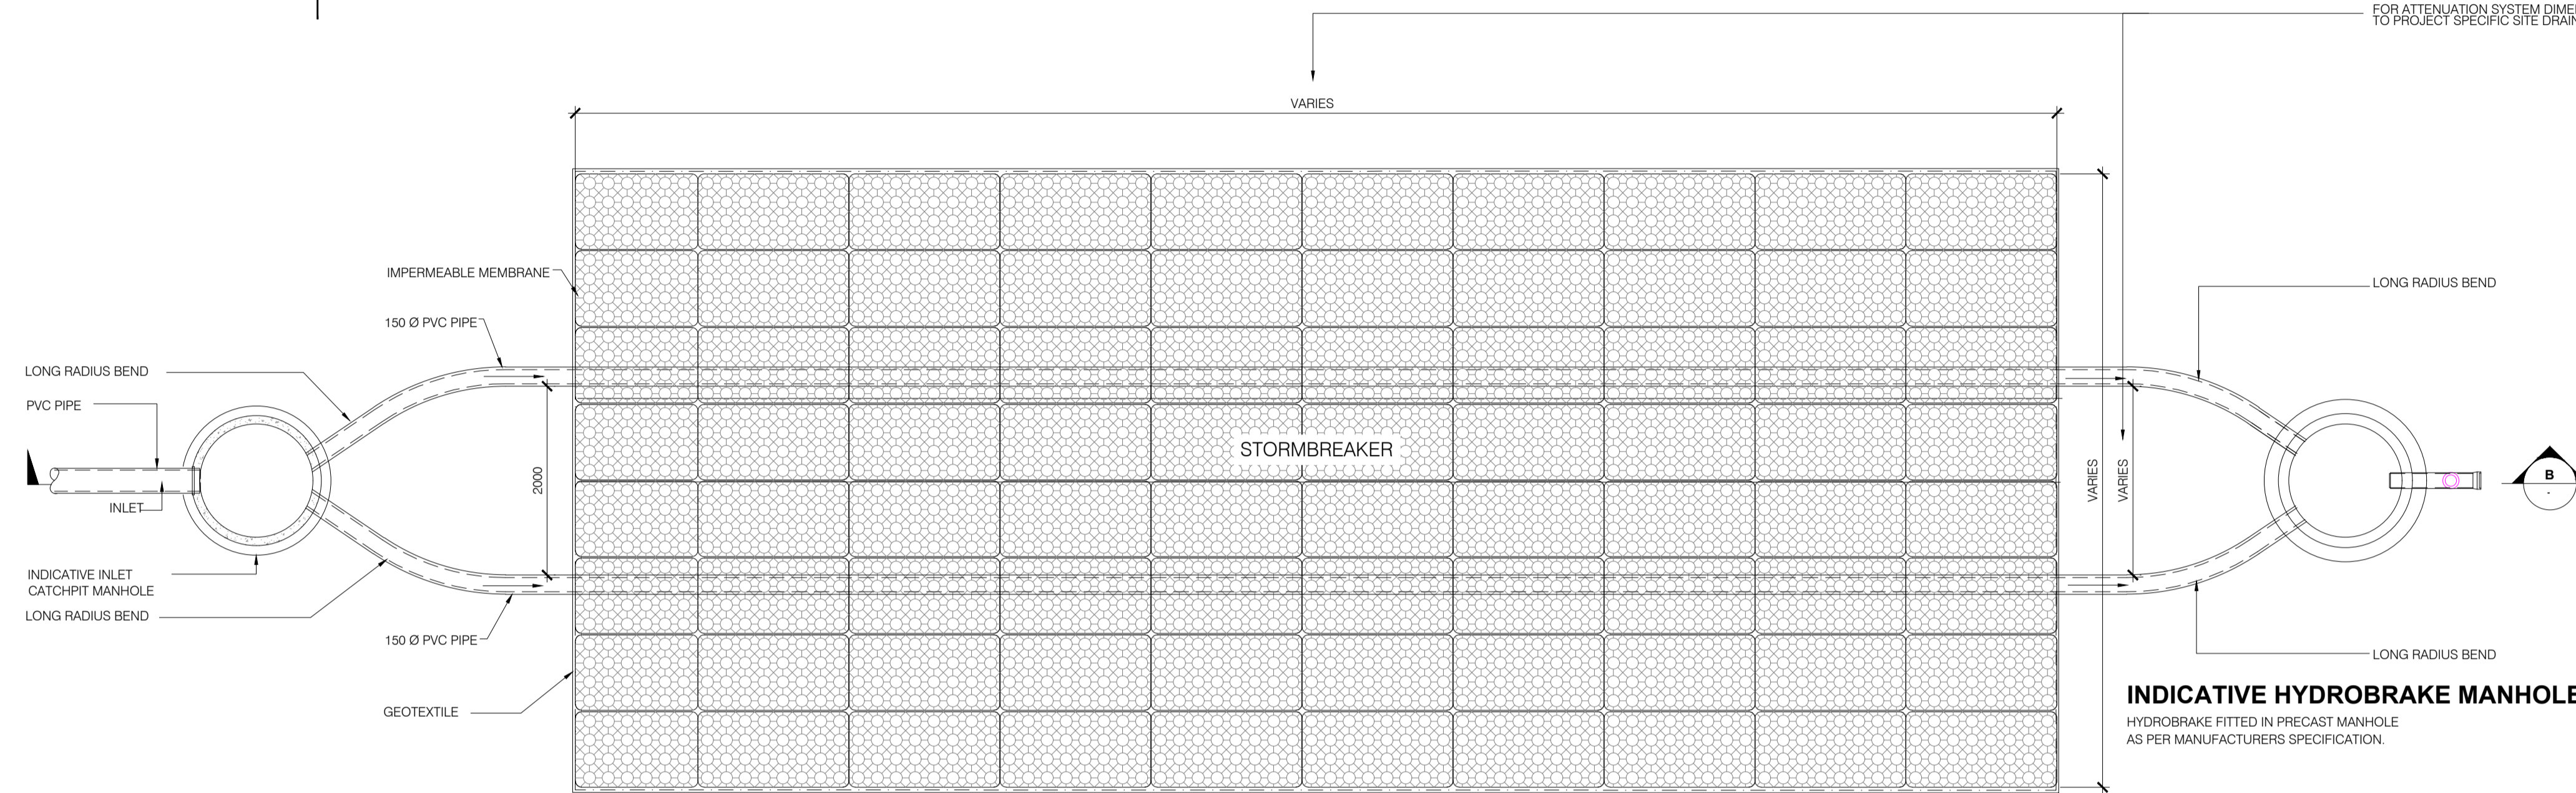

TYPICAL PLAN OF BMS STORMBREAKER ATTENUATION SYSTEM
SCALE 1:50



SECTION B
SCALE 1:50

- NOTES:
1. ALL DIMENSIONS IN mm UNLESS OTHERWISE STATED. NO DIMENSIONS SHALL BE SCALED FROM THE DRAWINGS.
 2. LEVELS PROVIDED ON THIS DRAWING ARE SHOWN RELATIVE TO FINISHED STONE LEVEL. FOR SITE SPECIFIC LEVELS, REFER TO SITE SECTIONS AND ELEVATIONS.
 3. THIS DRAWING IS FOR PLANNING PURPOSES ONLY AND NOT FOR CONSTRUCTION

REV	DATE	REVISION DESCRIPTION	DRN	PROD	VER	APP
0	06.11.25	ISSUED FOR PLANNING				

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PURPOSE OF ISSUE - PRELIMINARY UNLESS INDICATED
 CLIENT APPROVAL PLANNING TENDER CONSTRUCTION AS-BUILT

CLIENT

PROJECT **General Civil Drawings and Notes**

CONTRACT

DRAWING TITLE
**GENERAL DRAWINGS AND NOTES
 PLANNING
 TYPICAL ATTENUATION TANK**

PRODUCTION UNIT **Transmission and Distribution Delivery**

DRAWN	PRODUCED	VERIFIED	APPROVED	APPROVAL DATE
L.McManus	L.McManus	S.Donnelly	K.O'Neill	05/11/2025
CLIENT REF	NO. OF SHTS	SIZE	SCALE	
TC234181	1	A1	As Shown	

DRAWING NUMBER **PG406-D100-088-019-000**